



- 1. TRACKFORM SHOWN IS INDICATIVE.
- SUPERELEVATION IS NOT SHOWN. THE AMOUNT OF APPLIED SUPERELEVATION IS SHOWN IN THE CURVE DATA TABLES.

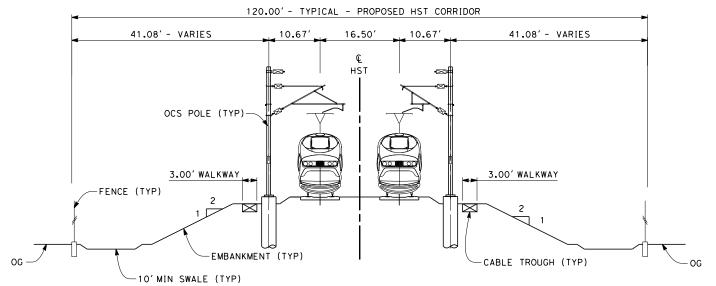

SECTION 1

TWIN TRACK AT GRADE STA 2029+93 THROUGH 2374+40

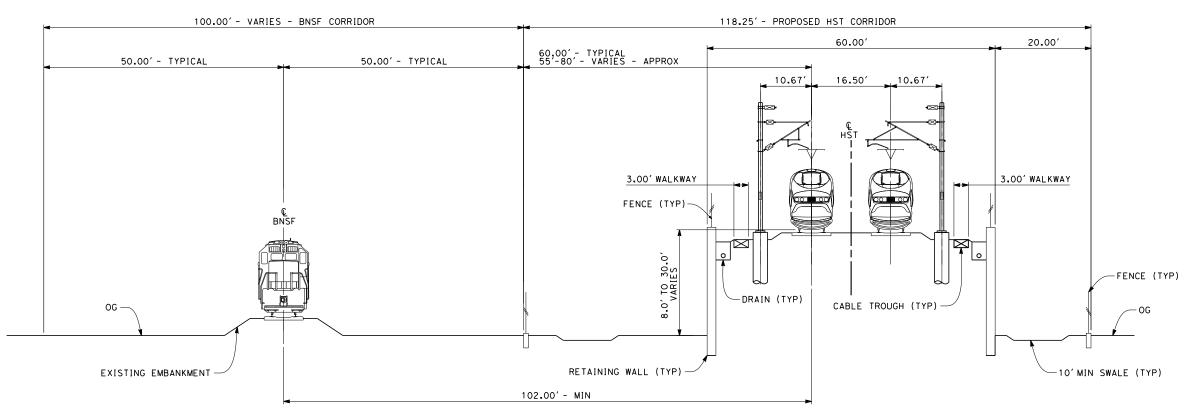

SECTION 2

TWIN TRACK ON RETAINED EMBANKMENT ADJACENT TO BNSF STA 2374+40 THROUGH 2405+73 STA 2554+98 THROUGH 2578+95



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710							DESIGNED BY A. POLING	
Jing							DRAWN BY J. BORGHESI	RECORD SET 15% Design Submission
r.po							CHECKED BY	-
xander							IN CHARGE R. COFFIN	NOT FOR Construction
<u>a</u> lex	REV	DATE	BY	СНК	APP	DESCRIPTION	12/31/13	






CALIFORNIA HIGH-SPEED TRAIN PROJECT FRESNO TO BAKERSFIELD

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SCALE	AS	SHO	NWC	
SHEET	^{NO.}	OF	15	

- 1. TRACKFORM SHOWN IS INDICATIVE.
- 2. SUPERELEVATION IS NOT SHOWN. THE AMOUNT OF APPLIED SUPERELEVATION IS SHOWN IN THE CURVE DATA TABLES.
- 3. FOR STRUCTURE DIMENSIONS SEE STRUCTURAL CROSS SECTIONS.

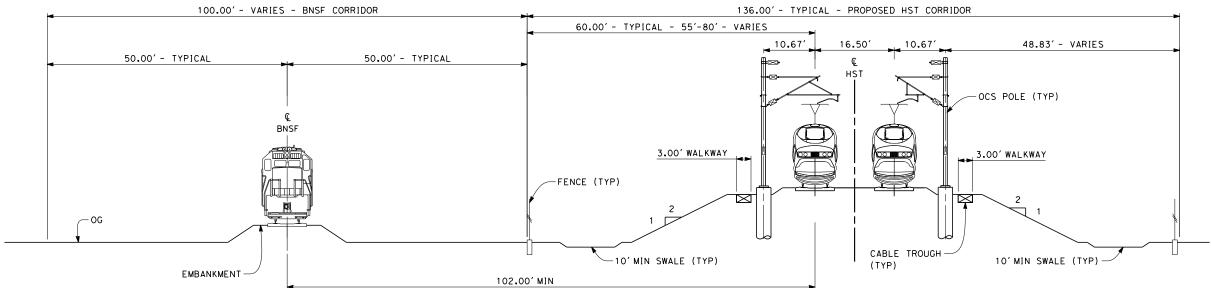

SECTION 4

TWIN TRACK ADJACENT TO SINGLE TRACK BNSF STA 2578+95 TO 2601+70




						DESIGNED BY A. POLING	
<u> </u>						DRAWN BY J. BORGHESI	RECORD SET 15% Design submission
·						CHECKED BY	-
						IN CHARGE R. COFFIN	NOT FOR Construction
REV	DATE	BY	СНК	APP	DESCRIPTION	DATE 12/31/13	





CALIFORNIA HIGH-SPEED TRAIN PROJECT FRESNO TO BAKERSFIELD

CONTRACT NO.						
HSR 06-0003						
DRAWING NO.						
CB3916						
SCALE						
AS SHOWN						
SHEET NO.						
14 OF 15						

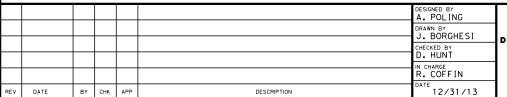

RECORD SET 15% DESIGN SUBMISSION NOT FOR CONSTRUCTION



80.00' - TYPICAL - PROPOSED HST CORRIDOR

16.50′

SECTION 5 TWIN TRACK TRUSS STA 2457+55 TO 2460+77

10.67

3.00' WALKWAY

10.67

3.00' WALKWAY

CABLE TROUGH (TYP)



NOTES:

- 1. TRACKFORM SHOWN IS INDICATIVE.
- 2. SUPERELEVATION IS NOT SHOWN, THE AMOUNT OF APPLIED SUPERELEVATION IS SHOWN IN THE CURVE DATA TABLES.
- 3. FOR STRUCTURE DIMENSIONS SEE STRUCTURAL CROSS SECTIONS.

CALIFORNIA HIGH-SPEED TRAIN PROJECT FRESNO TO BAKERSFIELD

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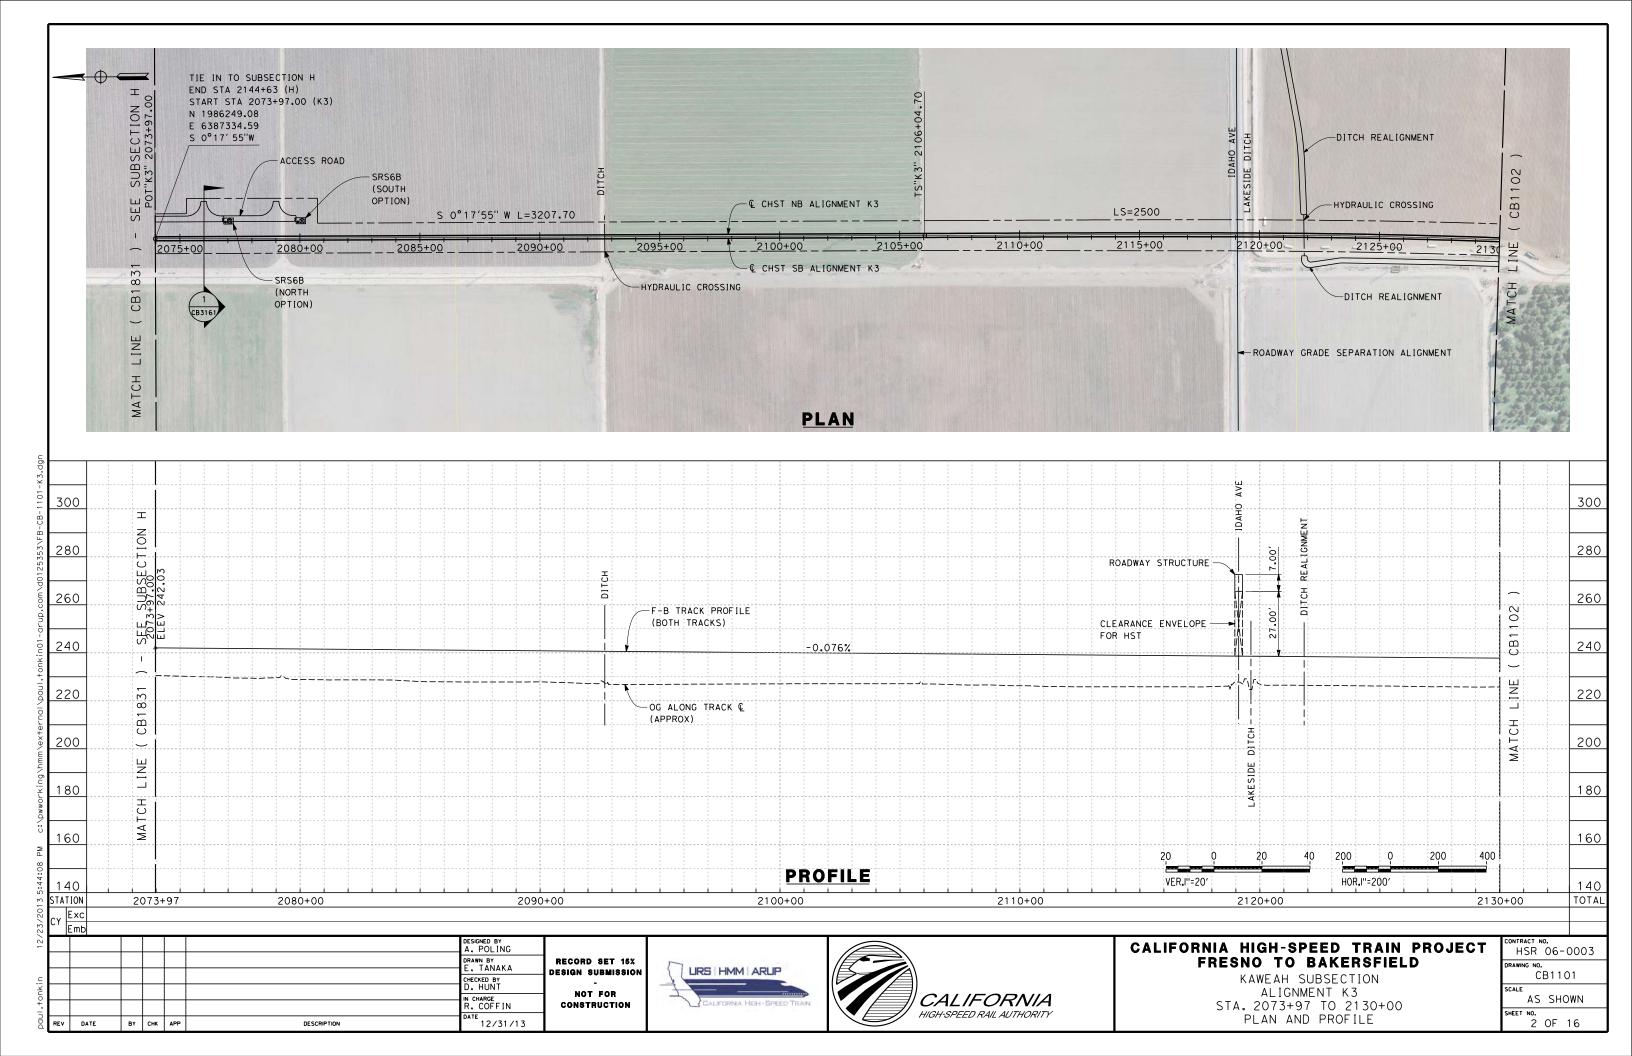
BY CHK APP


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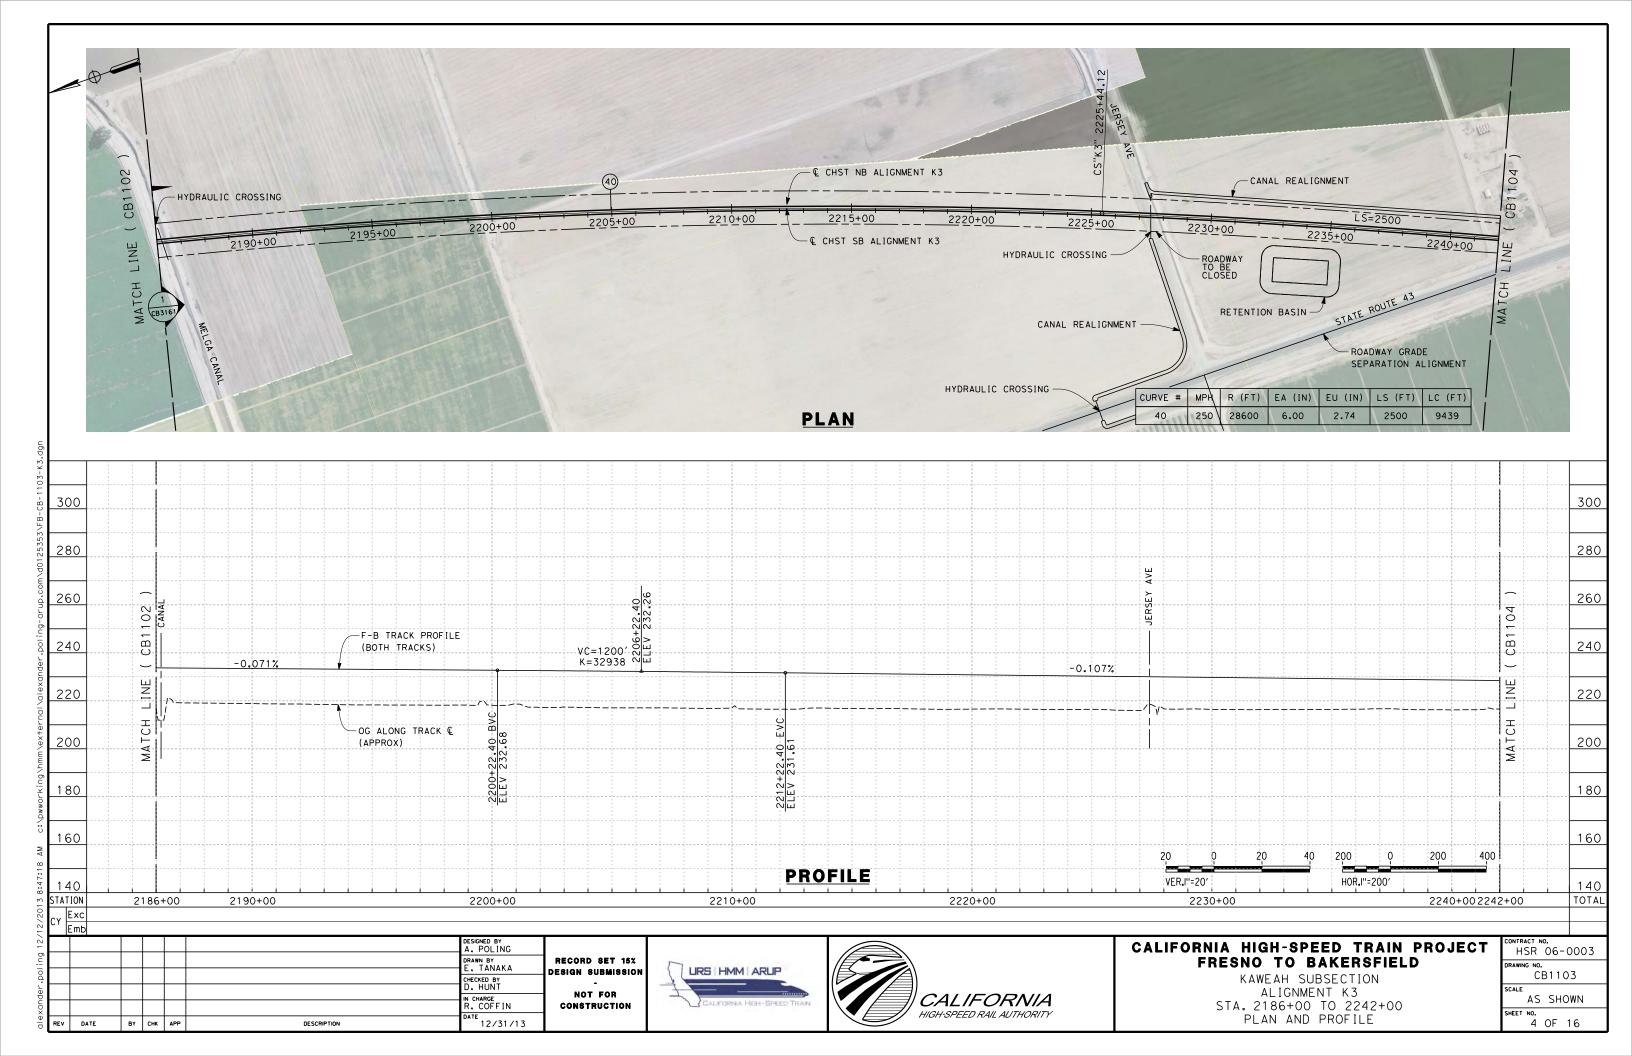
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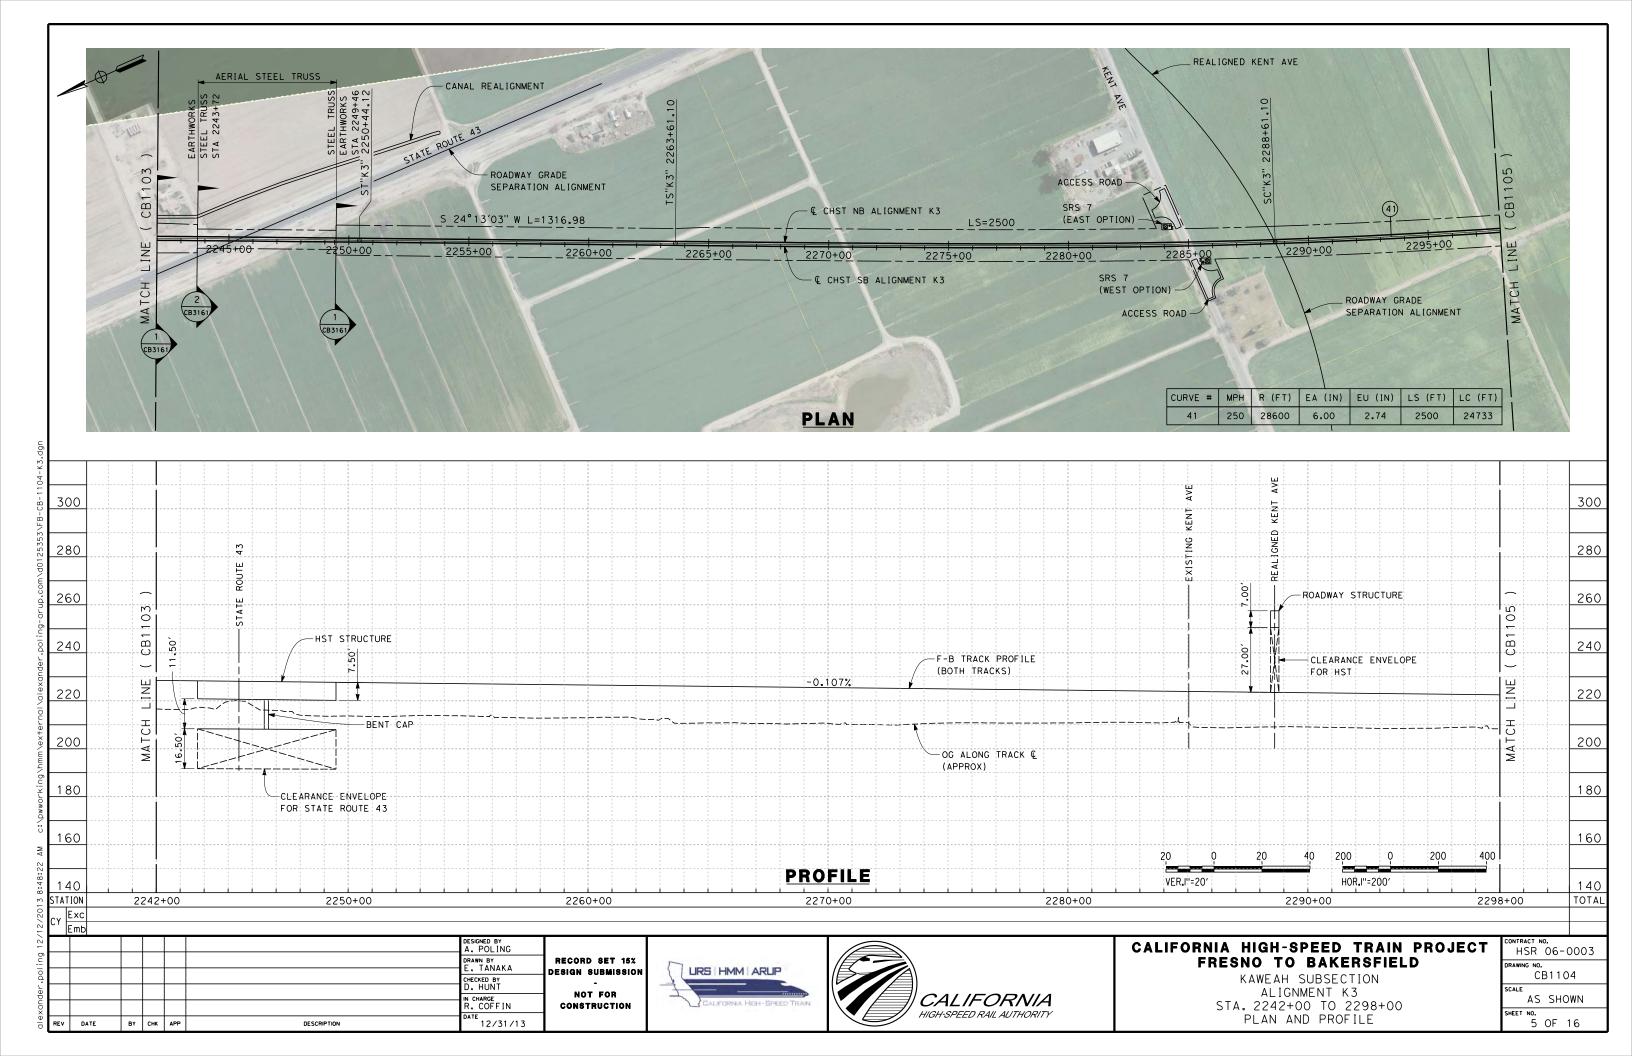
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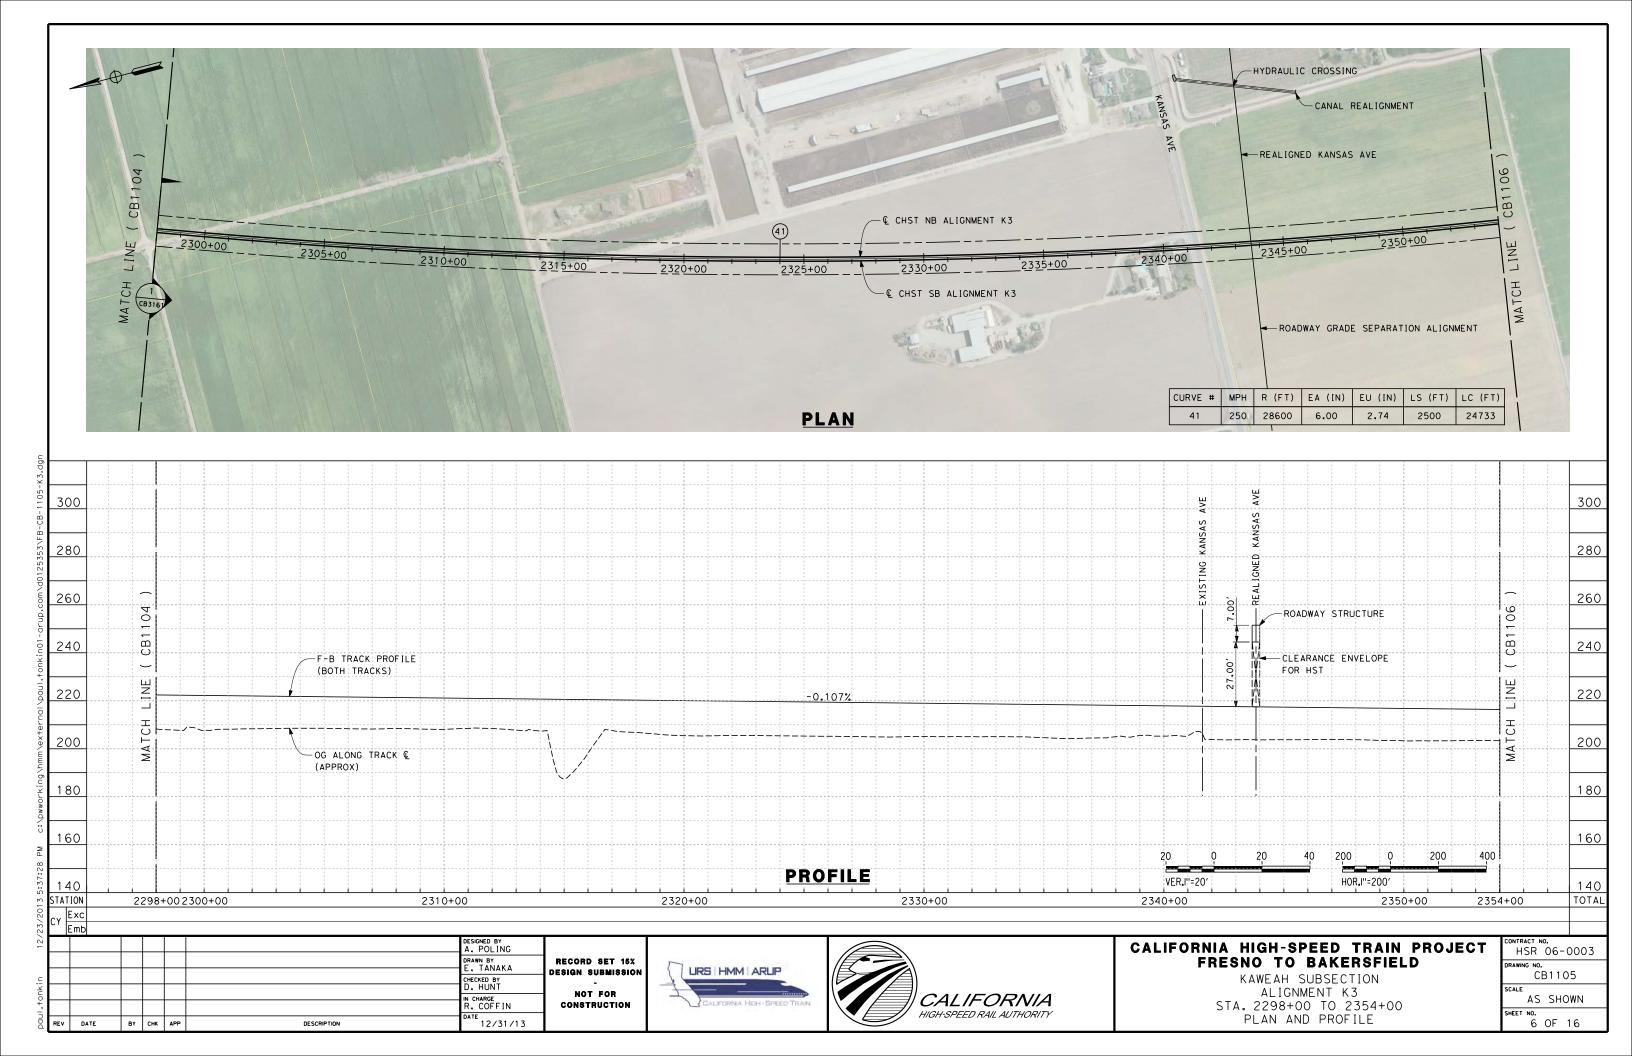
1 OF 16












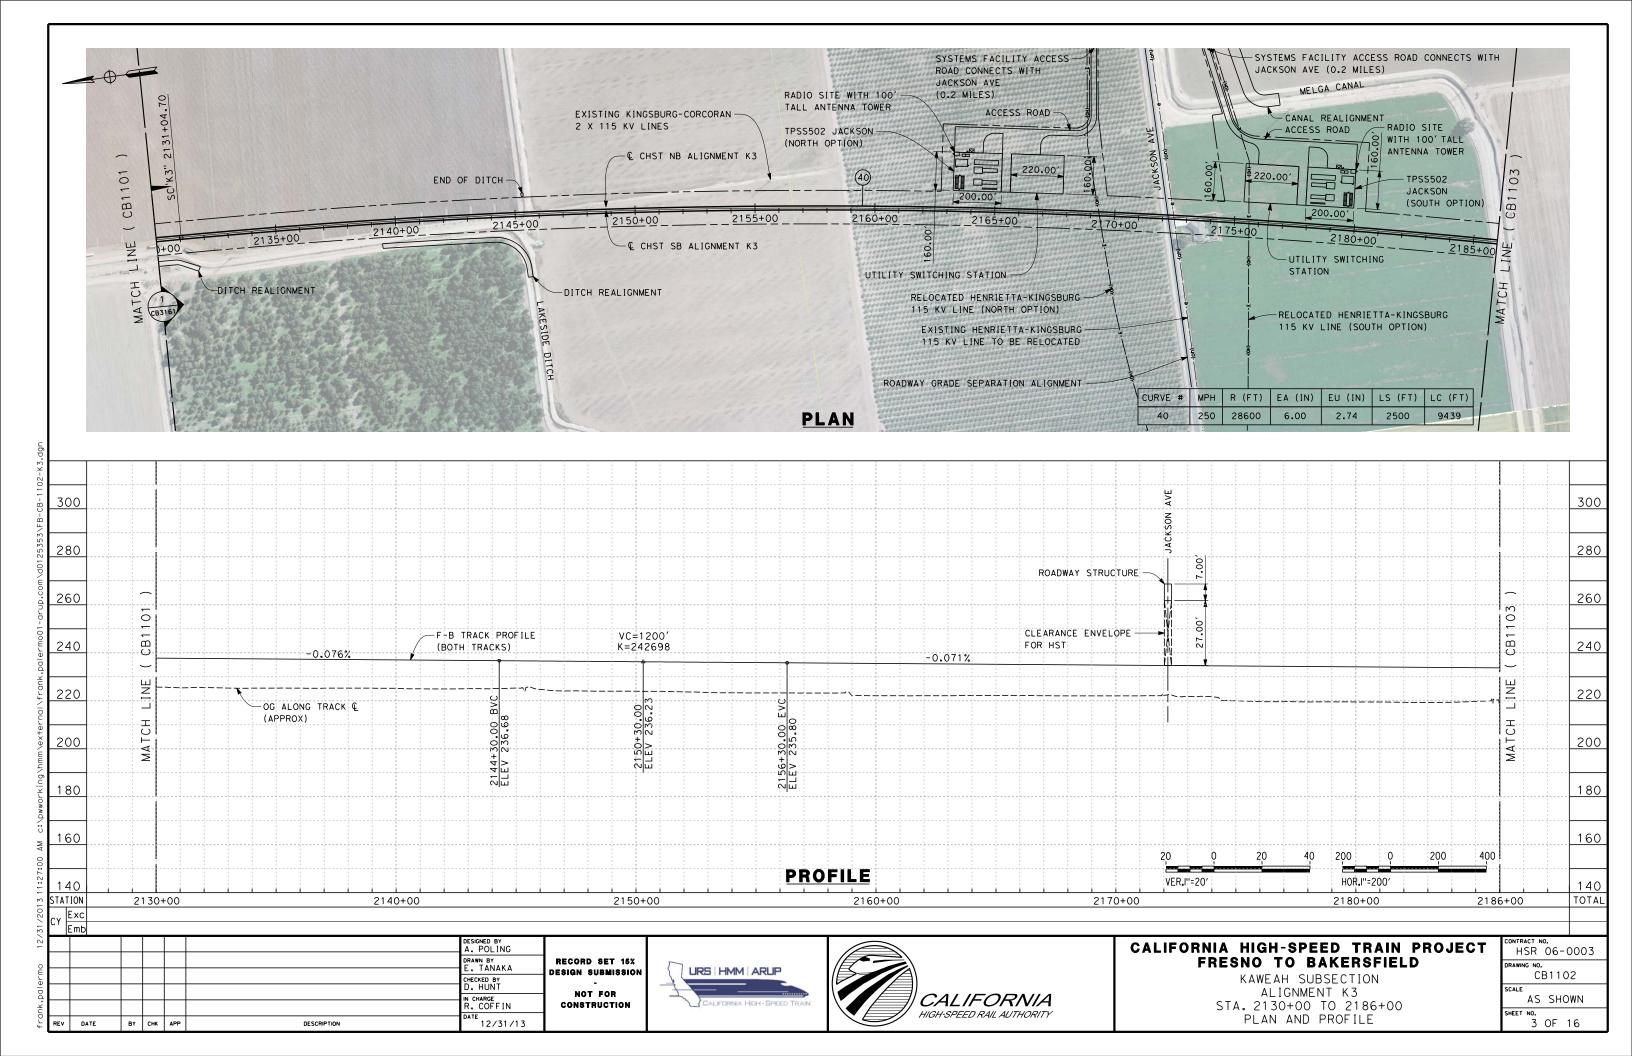

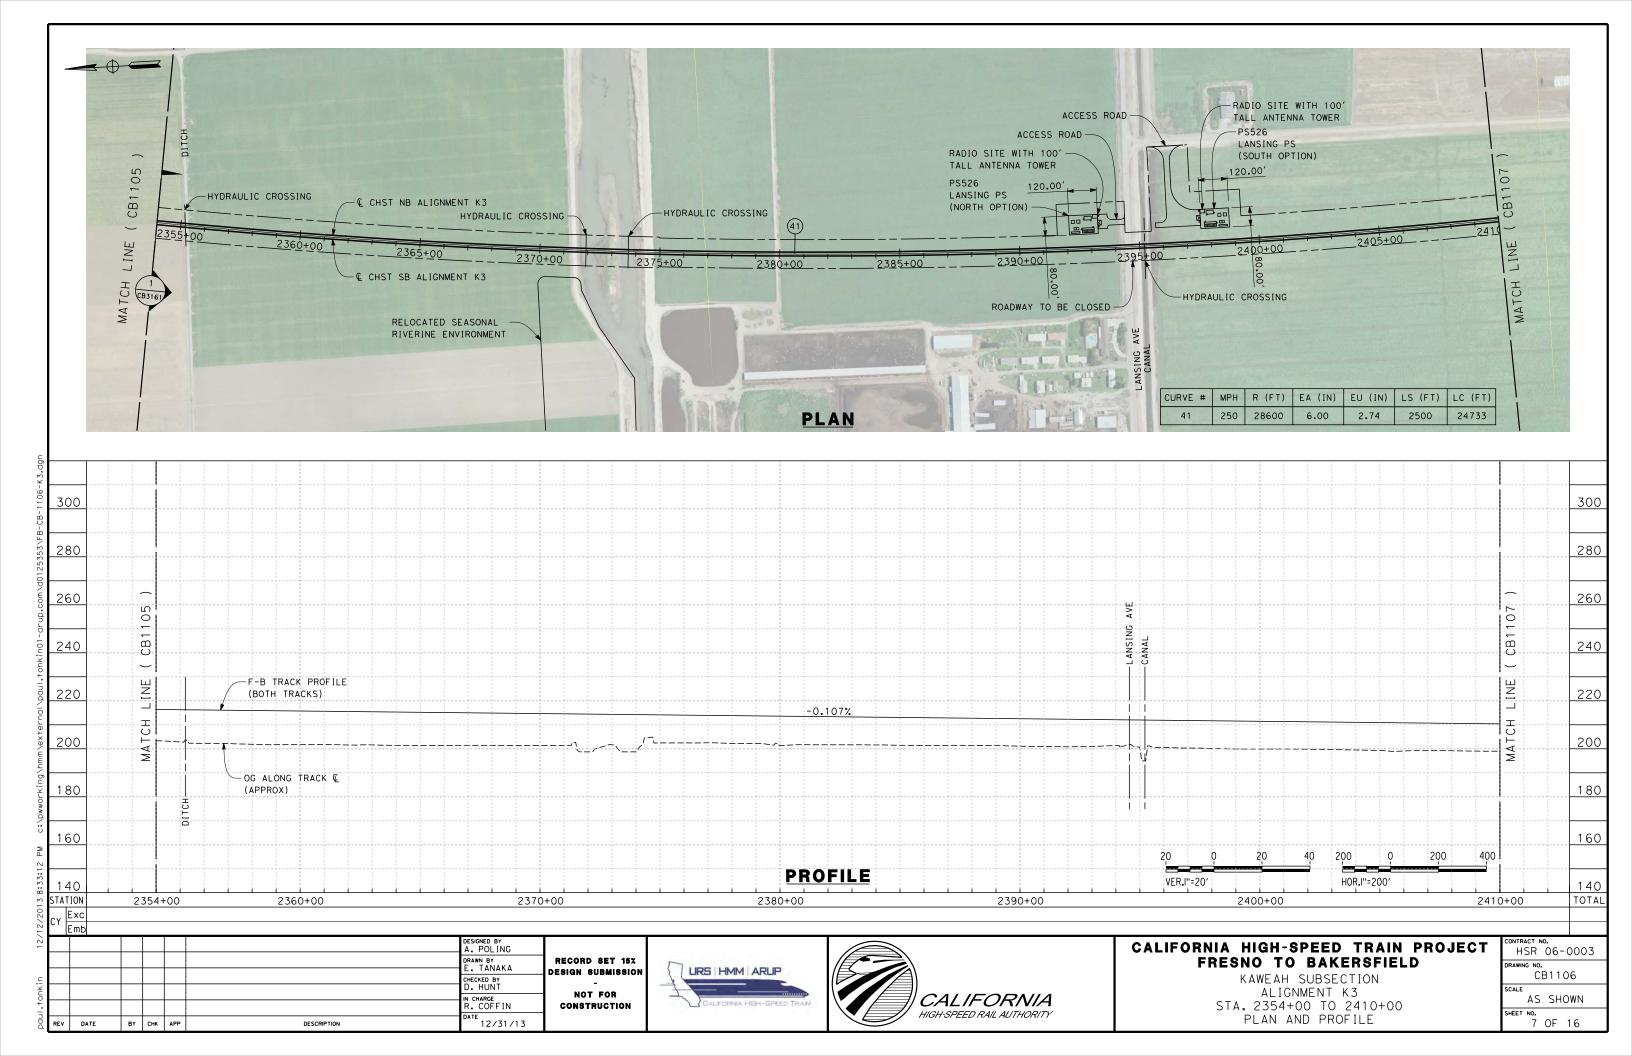

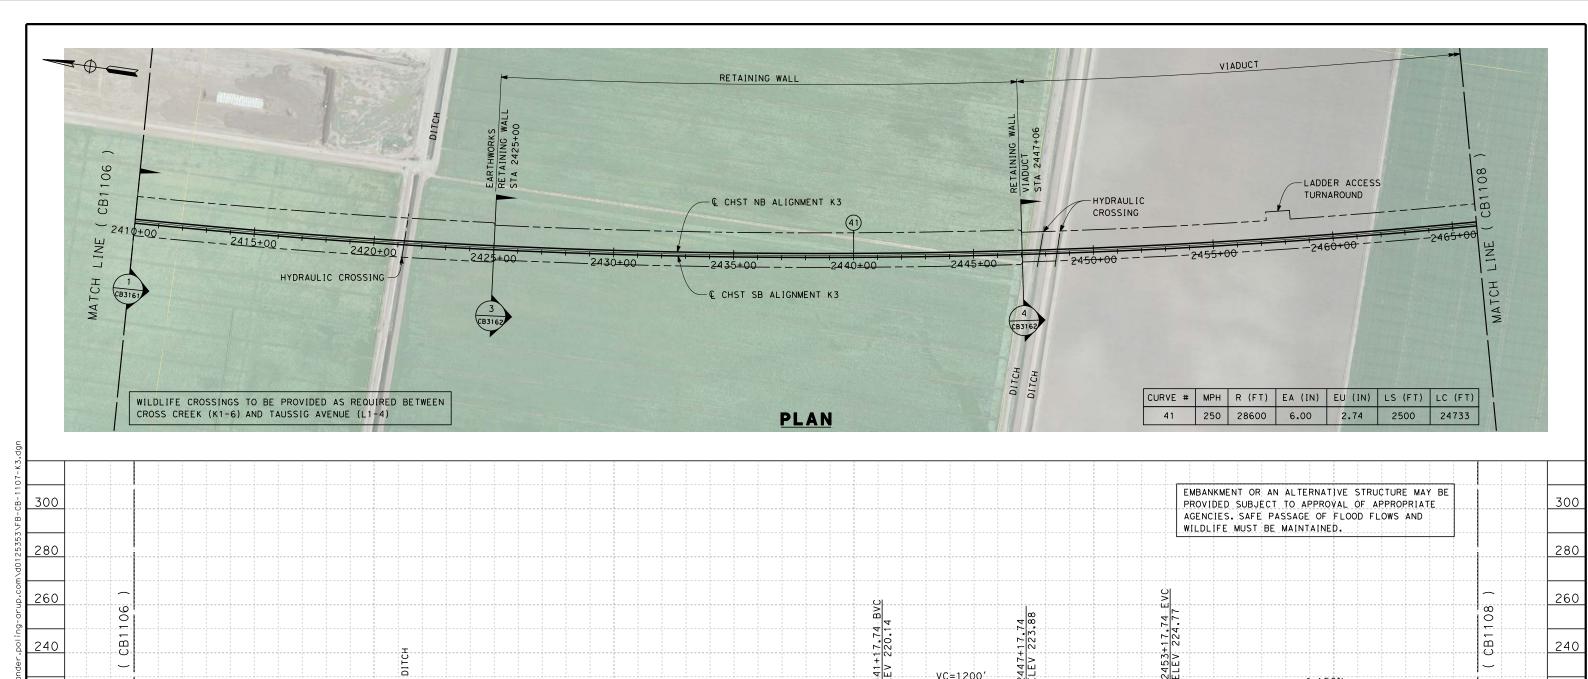

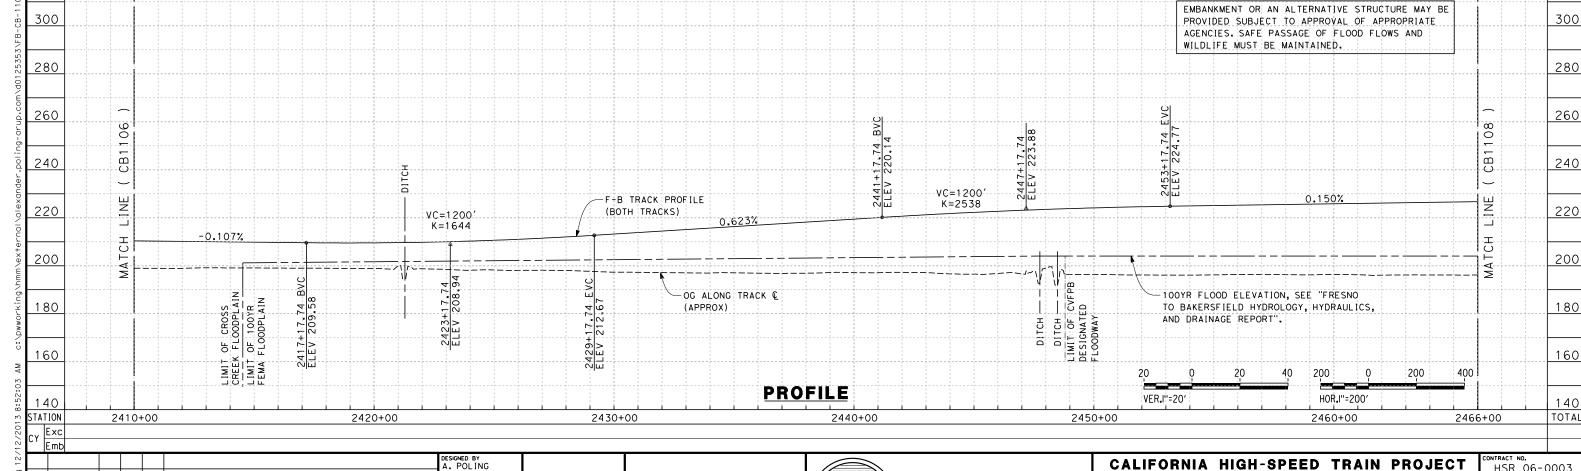

URS HMM ARUP

DRAWN BY E. TANAKA

N CHARGE R. COFFIN

12/31/13

CHECKED BY

DATE

BY CHK APP

DESCRIPTION

RECORD SET 15%

DESIGN SUBMISSION

NOT FOR

CONSTRUCTION



CALIFORNIA HIGH-SPEED TRAIN PROJECT FRESNO TO BAKERSFIELD


KAWEAH SUBSECTION
ALIGNMENT K3
STA. 2410+00 TO 2466+00
PLAN AND PROFILE


CONTRACT NO.
HSR 06-0003


DRAWING NO.
CB1107

SCALE
AS SHOWN


SHEET NO.
8 OF 16

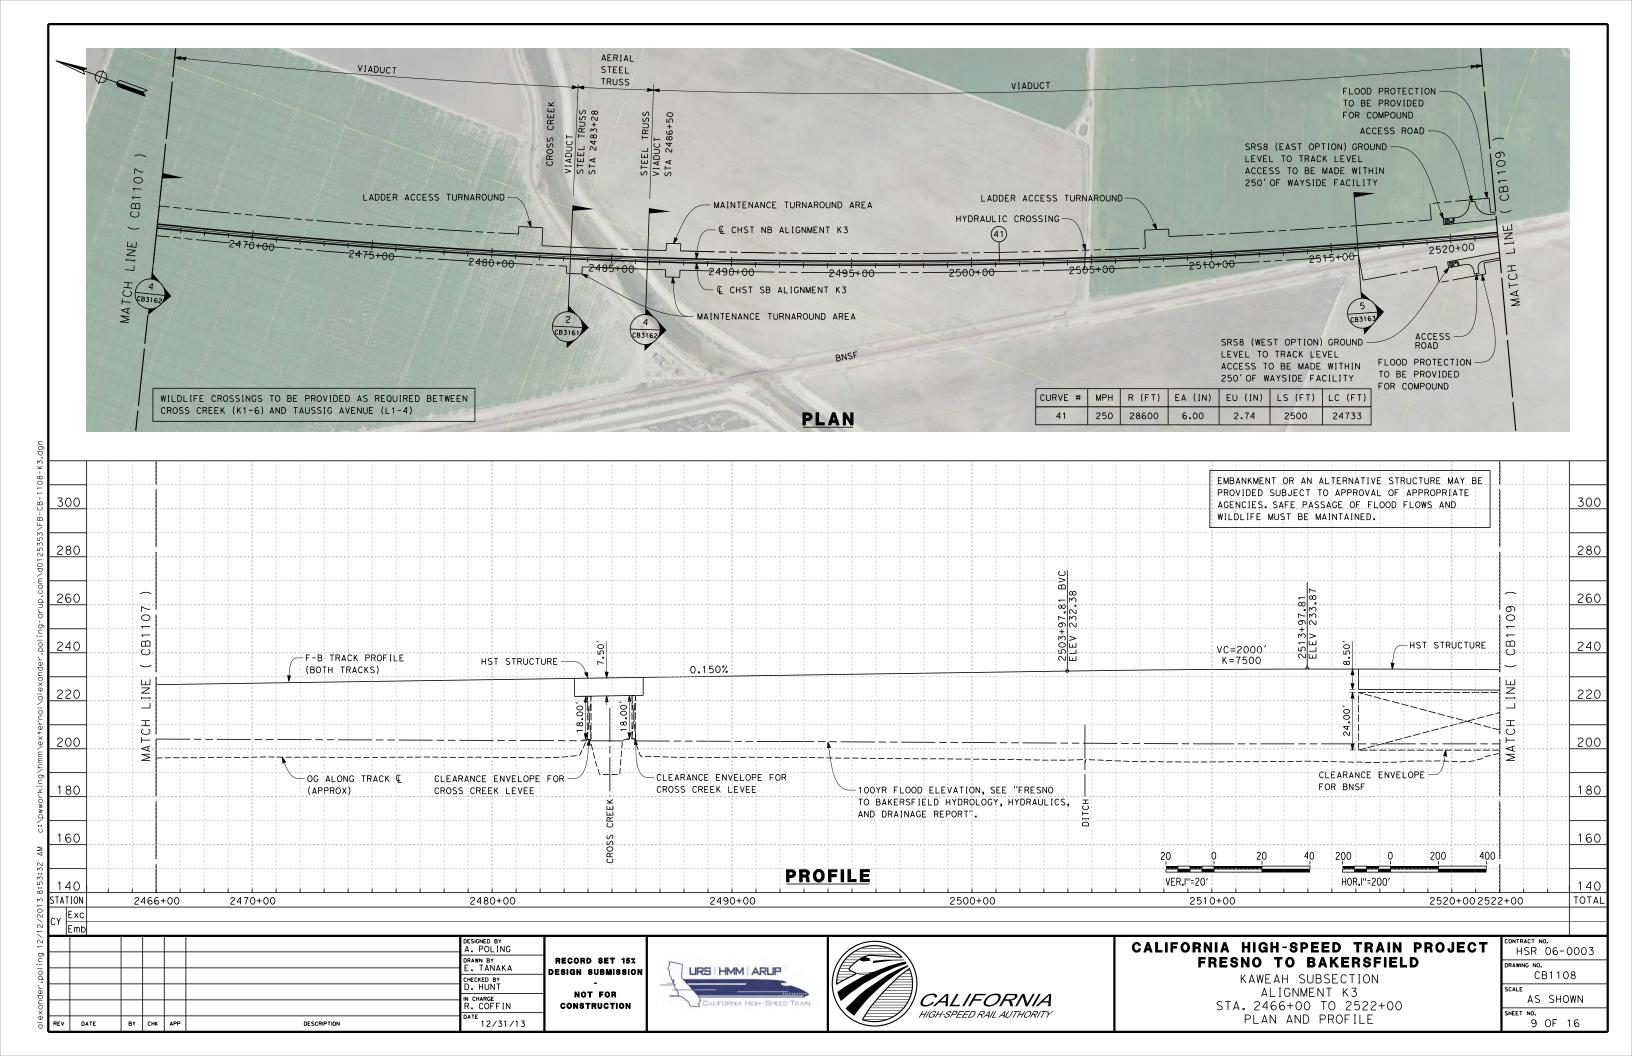

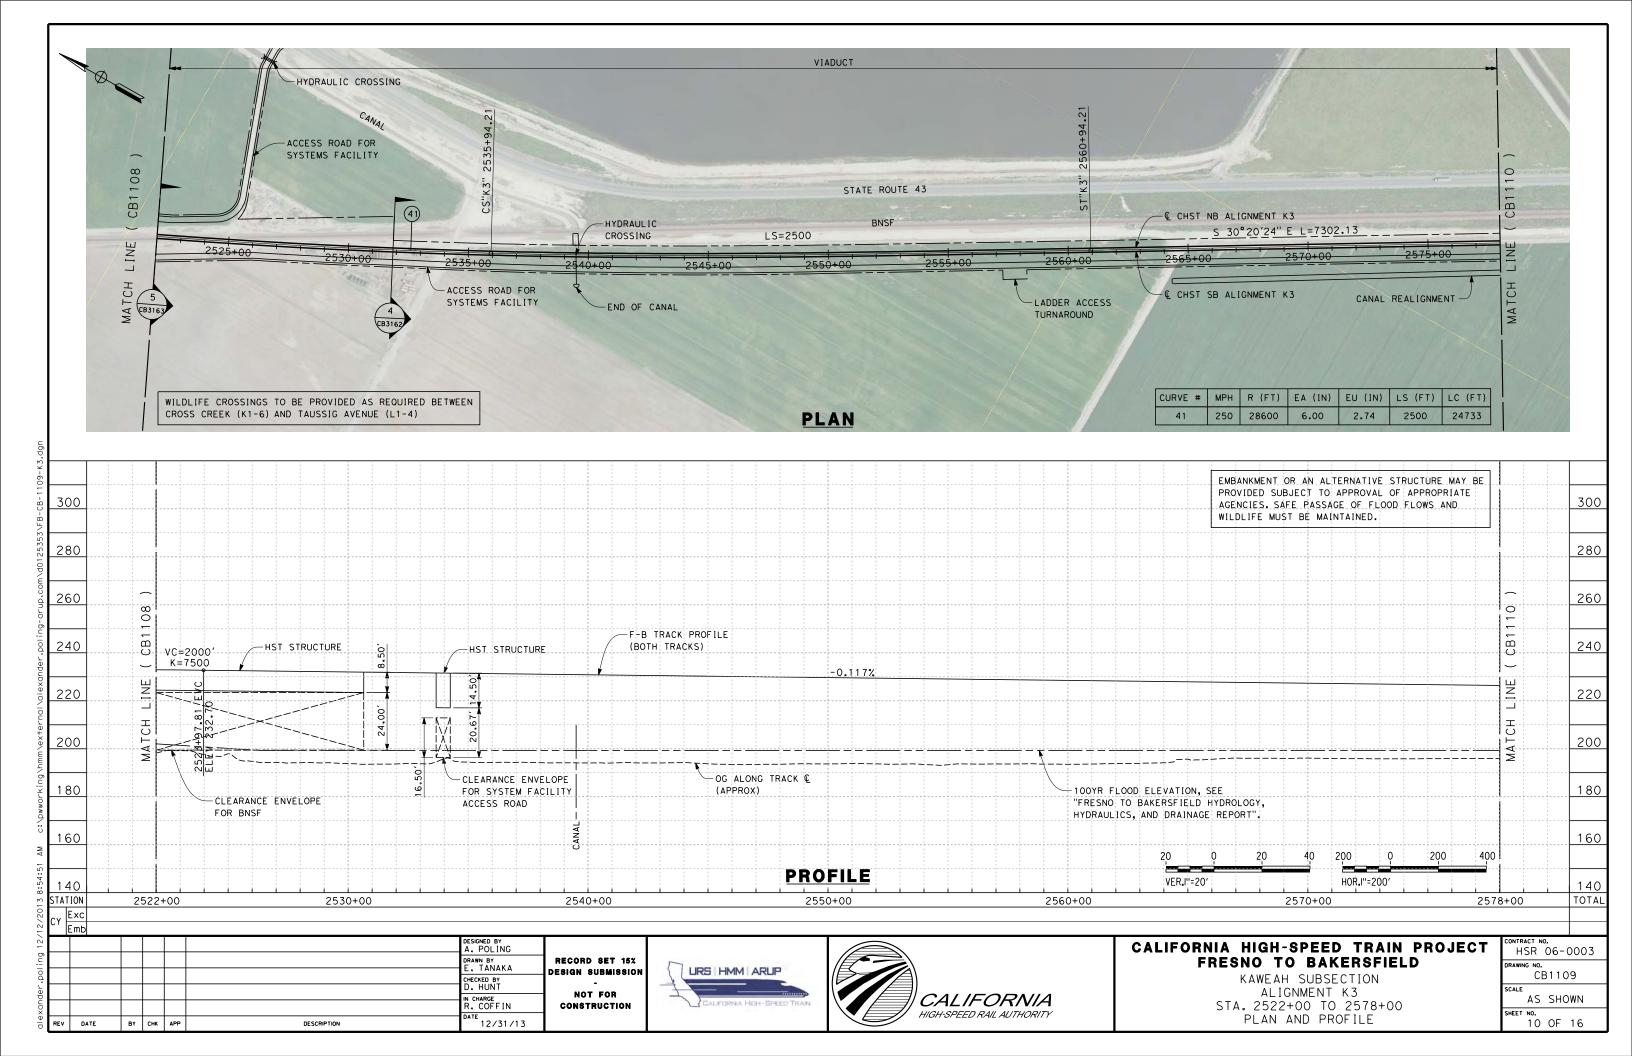

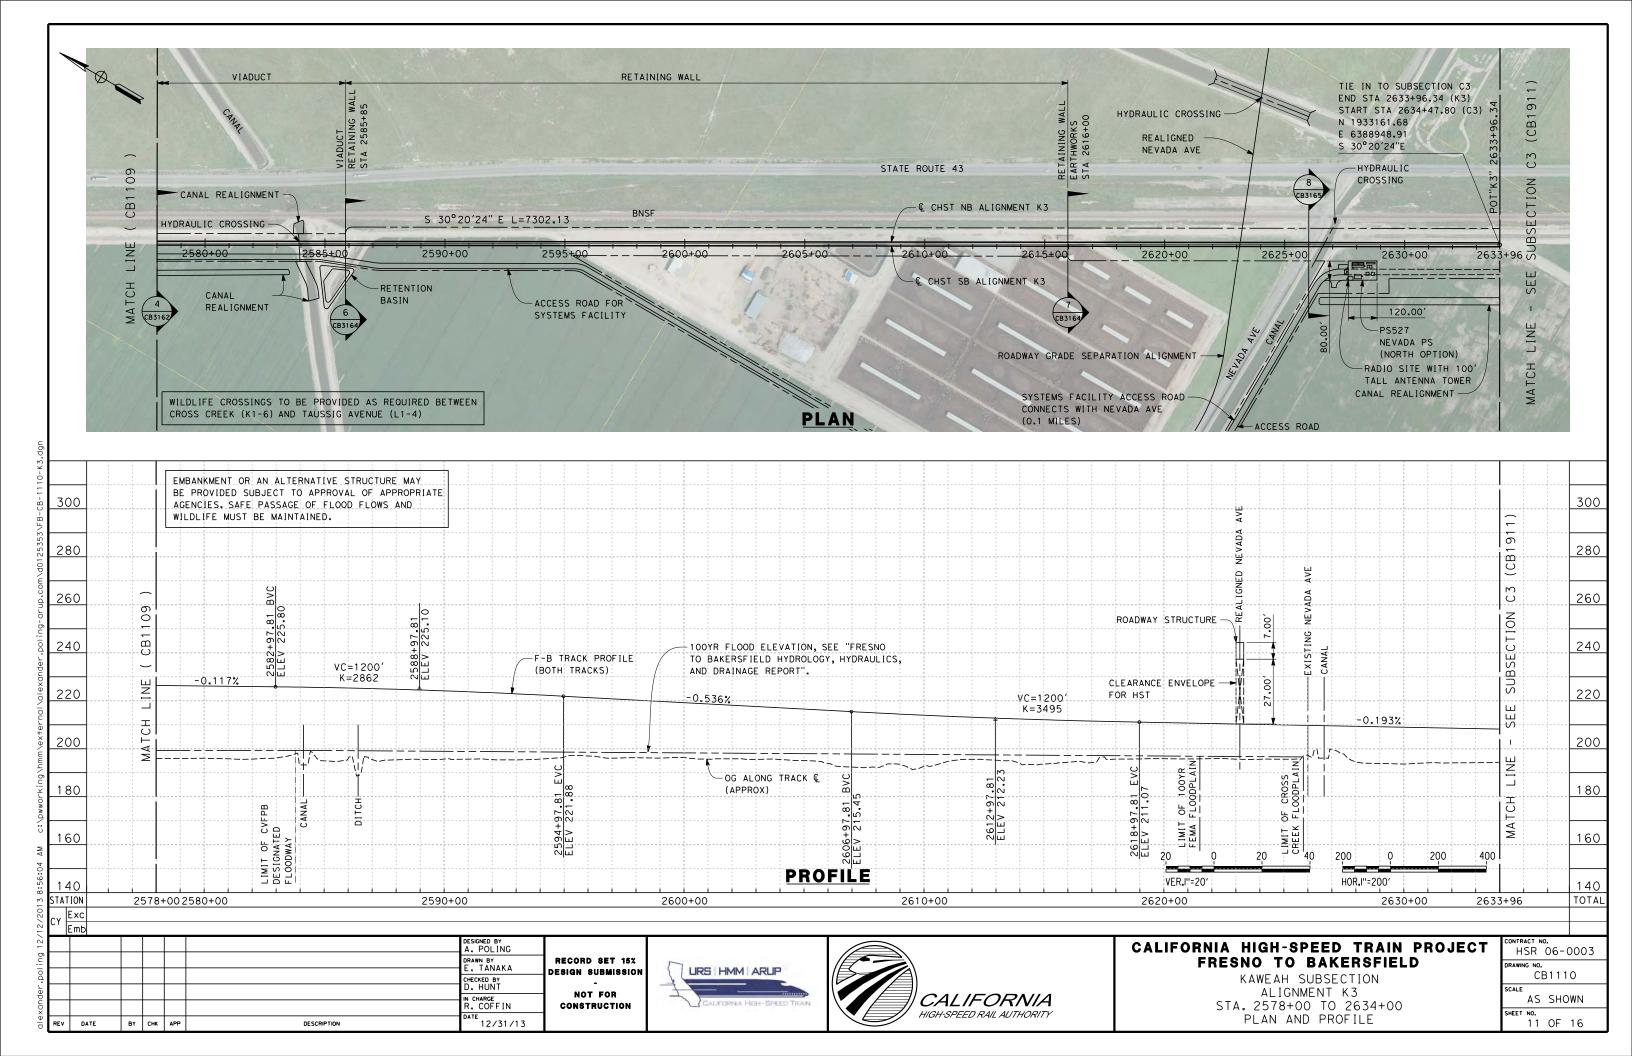


- 1. TRACKFORM SHOWN IS INDICATIVE
- 2. FOR STRUCTURE DIMENSIONS SEE STRUCTURAL CROSS SECTIONS
- 3. SUPERELEVATION IS NOT SHOWN.
 THE AMOUNT OF APPLIED
 SUPERELEVATION IS SHOWN IN
 THE CURVE DATA TABLES.

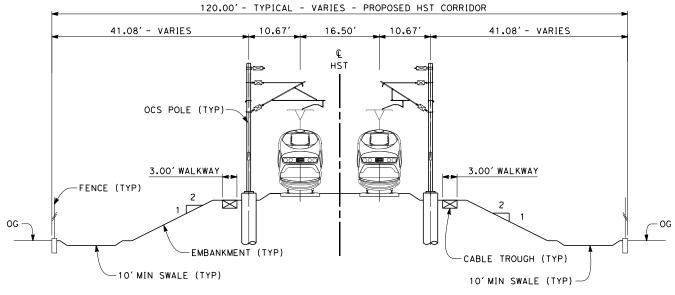

SECTION 1

TWIN TRACK - AT-GRADE WITH OPEN DRAINAGE STA 2073+97 THROUGH STA 2243+72 STA 2249+46 THROUGH STA 2425+00

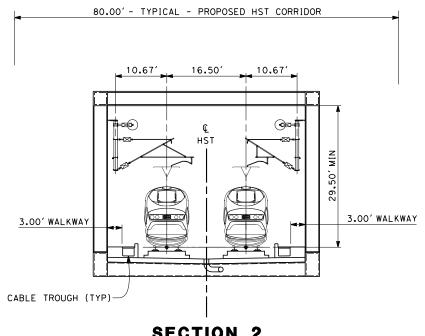

SECTION 2 TWIN TRACK TRUSS

STA 2243+72 THROUGH STA 2249+46 STA 2483+28 THROUGH STA 2486+50



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						DESIGNED BY A. POLING	
Ľ						DRAWN BY E. TANAKA	RE
L						CHECKED BY	DES
						D. HUNT IN CHARGE	ł
						R. COFFIN] c
RE	V DATE	ВΥ	СНК	APP	DESCRIPTION	12/31/13	









CALIFORNIA HIGH-SPEED TRAIN PROJECT FRESNO TO BAKERSFIELD

CONTRACT NO. HSR 06-0003						
DRAWING NO. CB3161						
SCALE						
AS SHOWN						
SHEET NO.						
12 OF 16						

- 1. TRACKFORM SHOWN IS INDICATIVE
- 2. FOR STRUCTURE DIMENSIONS SEE STRUCTURAL CROSS SECTIONS
- 3. SUPERELEVATION IS NOT SHOWN.
 THE AMOUNT OF APPLIED
 SUPERELEVATION IS SHOWN IN
 THE CURVE DATA TABLES.

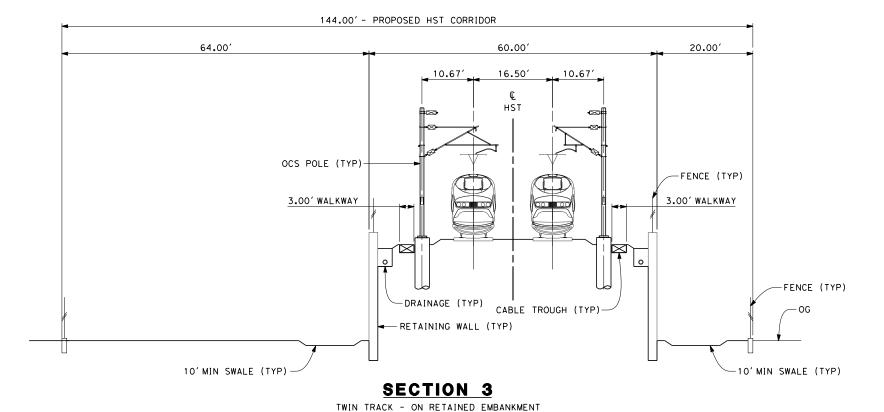

STA 2425+00 THROUGH STA 2447+06

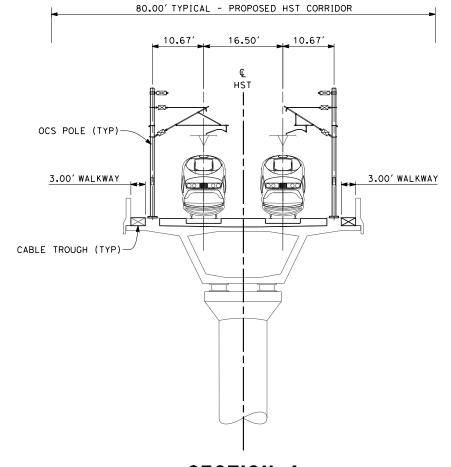

SECTION 4

TWIN TRACK - AERIAL VIADUCT STA 2447+06 THROUGH STA 2483+28 STA 2486+50 THROUGH STA 2516+11 STA 2531+85 THROUGH STA 2585+85



	DESIGNED BY A. POLING						
RE	DRAWN BY E. TANAKA						
DE8	CHECKED BY						
	D. HUNT						
C	R. COFFIN						
	DATE 12/31/13	DESCRIPTION	K APP	СНК	ВΥ	DATE	REV

RECORD SET 15%
ESIGN SUBMISSION
OF FOR
CONSTRUCTION






CALIFORNIA HIGH-SPEED TRAIN PROJECT FRESNO TO BAKERSFIELD

CONTRACT NO. HSR 06-0003					
DRAWING NO. CB3162					
SCALE AS SHOWN					
SHEET NO. 13 OF 16					

- 1. TRACKFORM SHOWN IS INDICATIVE
- 2. FOR STRUCTURE DIMENSIONS SEE STRUCTURAL CROSS SECTIONS
- 3. SUPERELEVATION IS NOT SHOWN.
 THE AMOUNT OF APPLIED
 SUPERELEVATION IS SHOWN IN
 THE CURVE DATA TABLES.

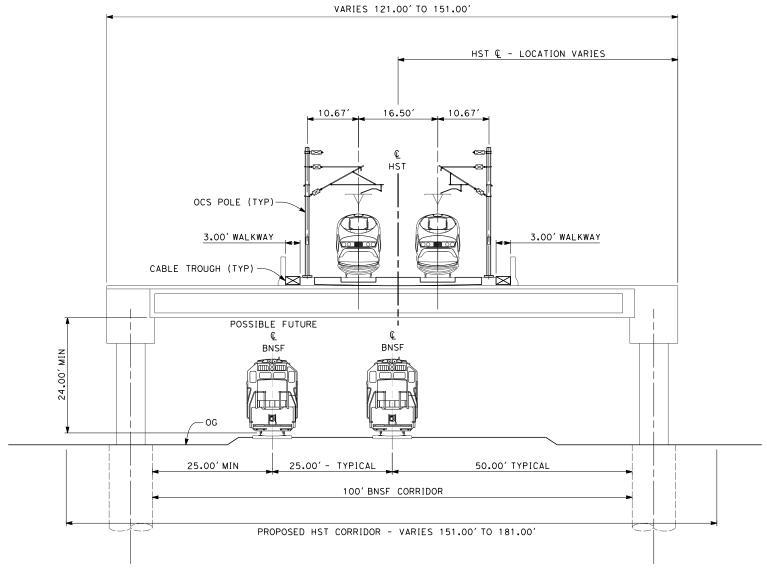

SECTION 5

TWIN TRACK - ELEVATED SLAB OVER BNSF STA 2516+11 THROUGH STA 2531+85



\$D∆							DESIGNED BY A. POLING	
							DRAWN BY E. TANAKA	RE DES
							CHECKED BY D. HUNT	DES
ER\$							IN CHARGE R. COFFIN] c
\$U\$	REV	DATE	ВΥ	СНК	APP	DESCRIPTION	12/31/13	


RECORD SET 15% Esign Submission -Not For Construction





CALIFORNIA HIGH-SPEED TRAIN PROJECT FRESNO TO BAKERSFIELD


•	CONTRACT NO. HSR 06-0003
	DRAWING NO. CB3163
	AS SHOWN
	SHEET NO. 14 OF 16

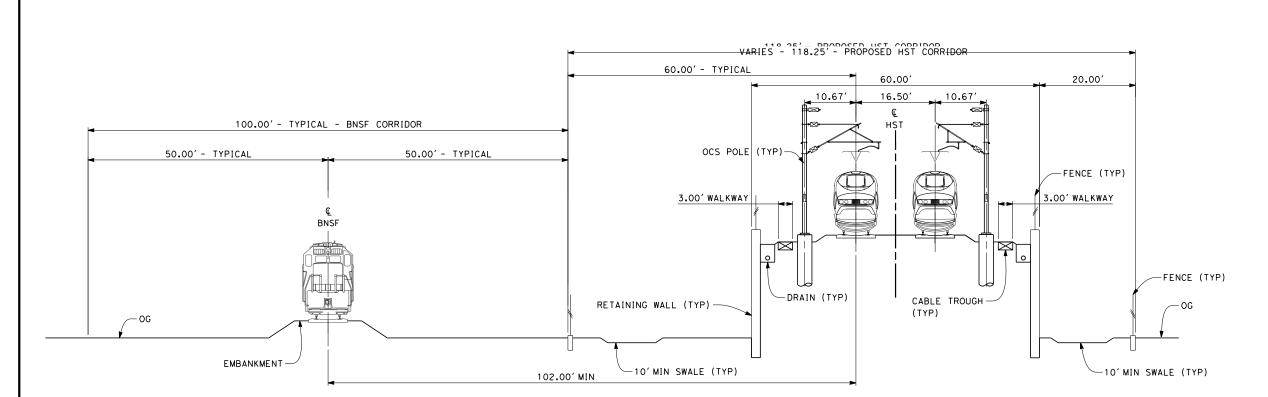

- 1. TRACKFORM SHOWN IS INDICATIVE
- 2. FOR STRUCTURE DIMENSIONS SEE STRUCTURAL CROSS SECTIONS
- 3. SUPERELEVATION IS NOT SHOWN.
 THE AMOUNT OF APPLIED
 SUPERELEVATION IS SHOWN IN
 THE CURVE DATA TABLES.

SECTION 6

TWIN TRACK - RETAINED EMBANKMENT ADJACENT TO SINGLE TRACK BNSF STA 2585+85 THROUGH STA 2616+00

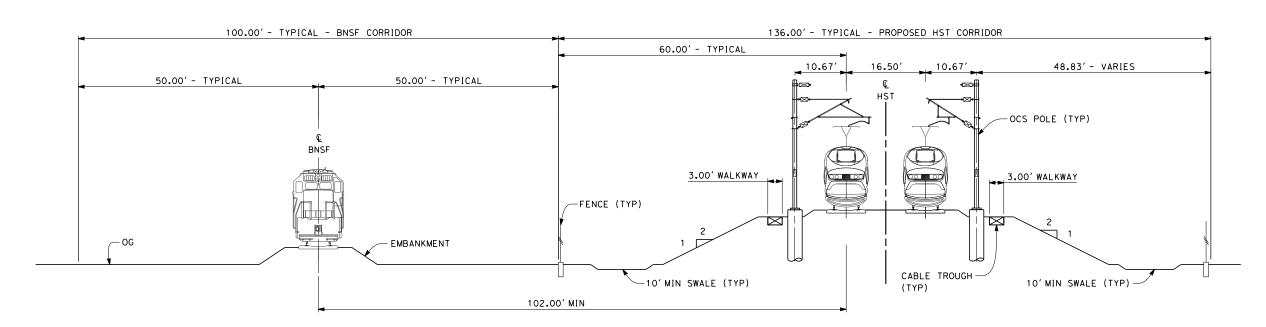

SECTION 7

TWIN TRACK - ADJACENT TO SINGLE TRACK BNSF STA 2616+00 THROUGH STA 2626+00



							DESIGNED BY A. POLING	
							DRAWN BY	RECORD SET 15%
L							CHECKED BY	DESIGN SUBMISSION
							D. HUNT IN CHARGE	NOT FOR
							R. COFFIN	CONSTRUCTION
,	REV	DATE	BY	СНК	APP	DESCRIPTION	12/31/13	





CALIFORNIA HIGH-SPEED TRAIN PROJECT FRESNO TO BAKERSFIELD

CONTRACT NO.
HSR 06-0003
DRAWING NO.
CB3164
SCALE
AS SHOWN
SHEET NO.
15 OF 16